

MAIN DRAWINGS

DESIGN AND SUPERVISION CONSULTANCY FOR REHABILITATION WORKS AT AL-BEIRUNI SECONDARY BOYS SCHOOL IN AL-RAM



رام الله ـ خلف مجمع الاسراء التجاري

MINISTRY OF EDUCATION MOE
APR, 2025

Funded by:



ORG. No. G-000

LIST OF DRAWINGS

	ARCHITECT	TURAL DRA	AWINGS	Le
G-000	COVER PAGE			-
G-001	LIST OF DRAWINGS			
A-101	EXISTING GROUND FLOOR PLAN (SCALE 1-100)			
A-102	PREPARING WORK AT GROUND FLOOR (SCALE 1-100)			
A-103	PROPOSED GROUND FLOOR PLAN (SCALE 1-100)			
A-104	PROPOSED GROUND CEILING PLAN (SCALE 1-100)			
A-105	3D SHOTS (MAIN HALL)			
A-106	3D SHOTS (MAIN HALL)			
A-107	3D SHOTS (MAIN HALL)			
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Notes:
-ALL DIMENSIONS ARE IN CM.UNLESS NOTED
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-DIMENSIONS SHOULD NOT BE SCALED OUT -ALL LEVELS ARE IN M. UNLESS NOTED OTHERWISE

Legend:

SECTION NUMBER REFERENCE SHEET NUMBER

DETAIL NUMBER
REFERENCE SHEET NUMBER

FLOOR FINISH LEVEL
FLOOR CONCRETE LEVEL

LEVEL SIGN IN PLAN

WINDOW NUMBER
REFERENCE SHEET NUMBER

DOOR NUMBER
REFERENCE SHEET NUMBER

RC CONCRETE FOR COL.

CONCRETE

STONE WALL

HOLLOW BLOCKS
INSULATION RANDOPAN 3CM THICK

MINISTRY OF EDUCATION MOE

nded by:



Architectural & Engineering Firm:



رام الله ـ علق مجمع الحراء اللجاري DESIGN DRAWINGS

inst Name:

DESIGN AND SUPERVISION CONSULTANCY FOR REHABILITATION WORKS AT AL-BEIRUNI SECONDARY BOYS SCHOOL IN AL-RAM


Drawing Title

LIST OF DRAWINGS


Prepared by	Diyar Consultants Co.	Scale
Date	Apr,2025	Sheet No. G-001

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EXISTING EXTERNAL WALL ELEVATION SCALE 1/100

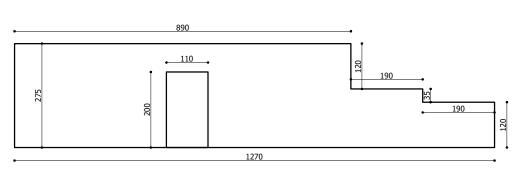

FLOOR HEIGHT = 4.85 M
FALSE CEILING HEIGHT = 4.00 M

EXISTING GROUND FLOOR PLAN DIMENSION LAYOUT SCALE 1/100

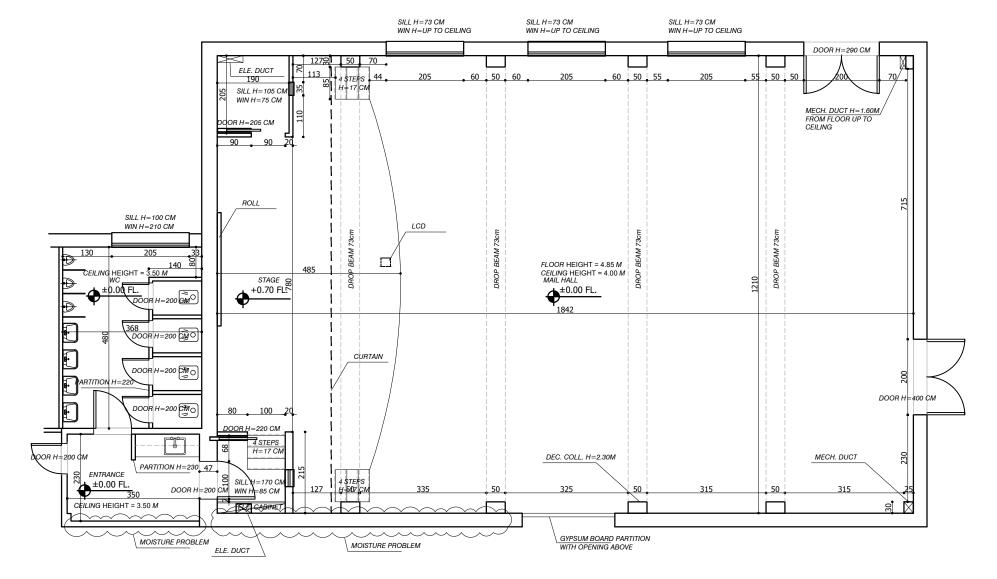Notes:
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Legend:

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FLOOR CONCRETE LEVEL

LEVEL SIGN IN PLAN

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REFERENCE SHEET NUMBER
DOOR NUMBER
REFERENCE SHEET NUMBER

CONCRETE FOR COL.
STONE WALL
HOLLOW BLOCKS
INSULATION RANDOPAN 3CM THICK

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DESIGN DRAWINGS

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Project Name:

DESIGN AND SUPERVISION CONSULTANCY FOR REHABILITATION WORKS AT AL-BEIRUNI SECONDARY BOYS SCHOOL IN AL-RAM

Drawing Title

EXISTING GROUND FLOOR PLAN

Prepared by	Diyar Consultants Co.	1:100 @ A3
Date	Apr,2025	Sheet No. A-101

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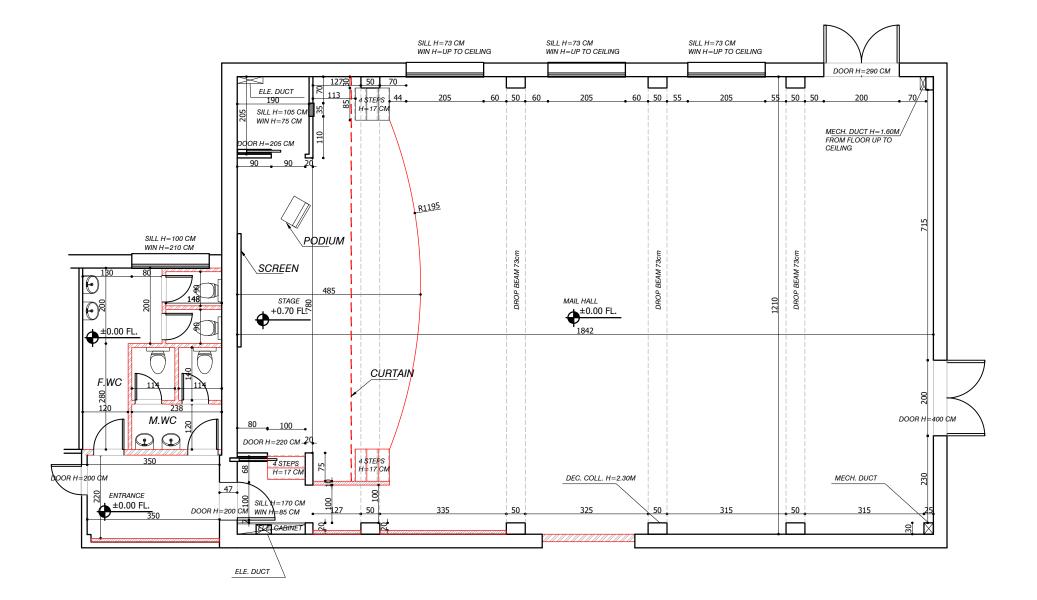
SECTION NUMBER
REFERENCE SHEET NUMBER DETAIL NUMBER
REFERENCE SHEET NUMBER FLOOR FINISH LEVEL
FLOOR CONCRETE LEVEL EXISTING DOOR TO LEVEL SIGN IN PLAN EXISTING SHUTTERS TO BE INVERSE OPENING BE REMOVED & **DIRECTION &** REPLACED WITH NEW WINDOW NUMBER
REFERENCE SHEET NUMBER **PAINTING ELECTRICAL SHUTTERS** DOOR NUMBER
REFERENCE SHEET NUMBER RC CONCRETE FOR COL. SILL H=73 CM
SILL H=73 CM
WINH=UP TO SEILING SILL H=73 CM CONCRETE STONE WALL DOOR H≠290 CM EXISTING DOOR NEED ////// HOLLOW BLOCKS MAINTENANCE INSULATION RANDOPAN 3CM THICK ELE. DUCT 190 SILL H=105 CM WIN H=75 CM ADJUSTED STEEL STR. ACCORDING FROM FLOOR UP TO TO NEW CURVE NORTH EXISTING FINISHED COVER OF STAGE TO BE REMOVED & RENEWED EXISTING ELECTRICAL CURTAIN NEED MAINTENANCE SILL H=100 CM WIN H=210 CM EXISTING DOOR NEED DESCRIPTION 12 **PAINTING** FLOOR HEIGHT = 4.85 M CEILING HEIGHT = 4.00 M MAIL HALL +0.70 FLE ±0.00 FL. CURTAIN EXISTING PARTITIONS, DOORS, WC, SINKS & URINAL TO BE REMOVED MINISTRY OF EDUCATION ±0.00 FL. CEILING HEIGHT = 3.50 M a 🗓 **Enabel** MOISTURE PROBLEM TO BE TREATED ELE. DUCT GYPSUM BOARD PARTITION
WITH OPENING ABOVE REMOVE ALL EXISTING MOISTURE PROBLEM TO BE TREATED CEILING. EXISTING STEPS TO BE **EXISTING PARTITION &** EXISTING PARTITION, **EXISTING PARTITION TO** CHANGED TO 3 STEPS WINDOW TO BE KITCHEN CABINETS & BE REMOVED & CLOSED H=23 CM REMOVED. COUNTER TO BE WITH BLOCK WALL STAGE & STEPS TO BE **REMOVED** REMOVED & SHIFTED رام الله ــ خلف مجمع الاسراء الثبتاري DESIGN DRAWINGS Project Name: **DESIGN AND SUPERVISION** CONSULTANCY FOR REHABILITATION WORKS AT **AL-BEIRUNI SECONDARY BOYS** SCHOOL IN AL-RAM FLOOR HEIGHT = 4.85 M PREPARING WORK AT GROUND PREPARING WORK FALSE CEILING HEIGHT = 4.00 M AT GROUND FLOOR FLOOR BEFORE STARTING Prepared by Diyar Consultants Co. SCALE 1/100 Apr,2025

1:100

@ A3

A-102

-ALL DIMENSIONS ARE IN CM.UNLESS NOTED OTHERWISE



FLOOR HEIGHT = 4.85 M
FALSE CEILING HEIGHT = 4.00 M

PROPOSED GROUND FLOOR PLAN SCALE 1/100

Notes:

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Legend:

SECTION NUMBER
REFERENCE SHEET NUMBER

FLOOR FINISH LEVEL
FLOOR FINISH LEVEL
FLOOR CONCRETE LEVEL

LEVEL SIGN IN PLAN

WINDOW NUMBER
REFERENCE SHEET NUMBER

DOOR NUMBER
REFERENCE SHEET NUMBER

DOOR NUMBER
REFERENCE SHEET NUMBER

CONCRETE
STONE WALL

HOLLOW BLOCKS
INSULATION RANDOPAN 3CM THICK

NORTH



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DESIGN DRAWINGS

Project Name:

DESIGN AND SUPERVISION CONSULTANCY FOR REHABILITATION WORKS AT AL-BEIRUNI SECONDARY BOYS SCHOOL IN AL-RAM

Drawing Title


PROPOSED GROUND FLOOR PLAN

Dans and bu	Diyar Consultants Co.	Scale
Prepared by	Diyar Consultants Co.	1:100
		@ A3
		Sheet No.
Date	Apr,2025	A-103


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-ALL DIMENSIONS ARE IN CM.UNLESS NOTED OTHERWISE -ALL LEVELS ARE IN M. UNLESS NOTED OTHERWISE SECTION NUMBER
REFERENCE SHEET NUMBER DETAIL NUMBER
REFERENCE SHEET NUMBER FLOOR FINISH LEVEL
FLOOR CONCRETE LEVEL LEVEL SIGN IN PLAN WINDOW NUMBER REFERENCE SHEET NUMBER DOOR NUMBER
REFERENCE SHEET NUMBER RC CONCRETE FOR COL. SILL H=73 CM WIN H=UP TO CEILING SILL H=73 CM WIN H=UP TO CEILING SILL H=73 CM WIN H=UP TO CEILING CONCRETE STONE WALL DOOR H=290 CM ////// HOLLOW BLOCKS INSULATION RANDOPAN 3CM THICK +2.60 F.C.L +3.60 F.C.L NORTH +3.60 F.C.L SILL H=100 CM WIN H=210 CM +3.60 F.C.L +3.60 F.C.L +2.60 F.C.L +2.60 F.C.L +3.60 F.C.L ю см +3.60 F.C.L +2.60 F.C.L +2.90 F.C.L 疑 **Enabel** ELE. DUCT Project Name: GYPSUM BOARD WITH PLASTER SKIM LIGHT COATING & EMULSION WHITE PAINT GRILL 600*600 * 20 mm THICK SUSPENDED SPOT LIGHT GYPSUM TILES . Ō PENDANT LIGHT 300* Var.*2 mm THICK ALUMINUM SUSPENDED LINEAR STRIPS. F.C.L FALSE CEILING LEVEL LINEAR LIGHT CEILING LAYOUT PROPOSED GROUND FLOOR CEILING LAYOUT Prepared by Diyar Consultants Co. SCALE 1/100

DESCRIPTION MINISTRY OF EDUCATION رام الله ــ خلف مجمع الاسراء الثجاري DESIGN DRAWINGS **DESIGN AND SUPERVISION** CONSULTANCY FOR REHABILITATION WORKS AT AL-BEIRUNI SECONDARY BOYS SCHOOL IN AL-RAM Drawing Title PROPOSED GROUND FLOOR 1:100 @ A3 Apr,2025 A-104



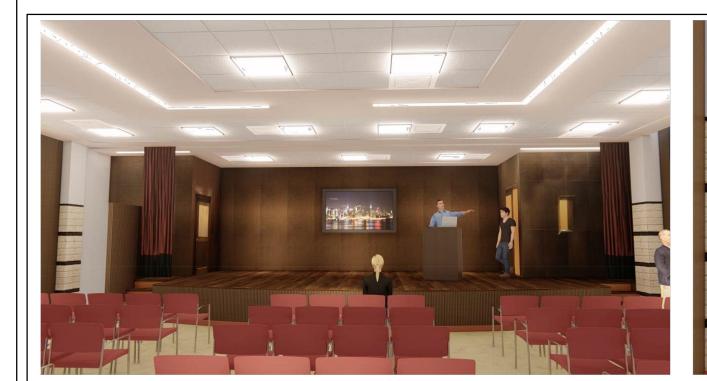



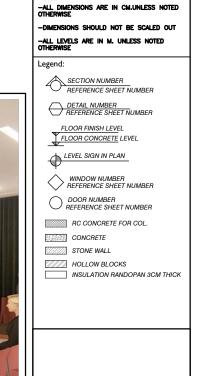



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DESCRIPTION





DESIGN DRAWINGS

Project Name:

DESIGN AND SUPERVISION
CONSULTANCY FOR
REHABILITATION WORKS AT
AL-BEIRUNI SECONDARY BOYS
SCHOOL IN AL-RAM

3D SHOTS (MAIN HALL)

Prepared by Diyar Consultants Co. Apr,2025 A-105











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DESCRIPTION






DESIGN DRAWINGS

roject Name:

DESIGN AND SUPERVISION
CONSULTANCY FOR
REHABILITATION WORKS AT
AL-BEIRUNI SECONDARY BOYS
SCHOOL IN AL-RAM

3D SHOTS (MAIN HALL)

Prepared by Diyar Consultants Co. N/A Apr,2025 A-106

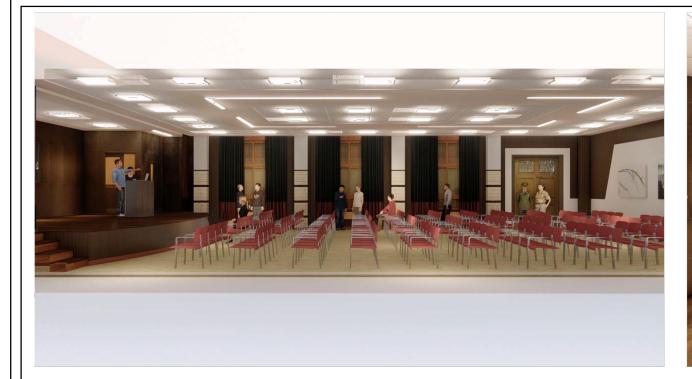



-DIMENSIONS SHOULD NOT BE SCALED OUT
-ALL LEVELS ARE IN M. UNLESS NOTED OTHERWISE
Legend:
SECTION NUMBER REFERENCE SHEET NUMBER
DETAIL NUMBER REFERENCE SHEET NUMBER
FLOOR FINISH LEVEL FLOOR CONCRETE LEVEL
LEVEL SIGN IN PLAN
WINDOW NUMBER REFERENCE SHEET NUMBER
DOOR NUMBER REFERENCE SHEET NUMBER
RC CONCRETE FOR COL.
CONCRETE
STONE WALL
HOLLOW BLOCKS INSULATION RANDOPAN 3CM THICK
INSULATION HANDOFAN SOM THICK





-ALL DIMENSIONS ARE IN CM.UNLESS NOTED OTHERWISE

DESCRIPTION

MINISTRY OF EDUCATION MOE





DESIGN DRAWINGS

Project Name:

DESIGN AND SUPERVISION
CONSULTANCY FOR
REHABILITATION WORKS AT
AL-BEIRUNI SECONDARY BOYS
SCHOOL IN AL-RAM

3D SHOTS (MAIN HALL)

Prepared by Diyar Consultants Co. Apr,2025 A-107

SYMBOL		DESCRIPTION
	HEIGHTS	LIGHTING FIXTURES
\overline{x}		DECORATIVE CHANDLIER
		Smart FLOOD LIGHT
O	:	Open Ceiling Lighting
	CEILING	30W SURFACE MOUNTED LIGHT WATER PROOF
© _w		18 W CEILING MOUNTED LIGHTING POINT/FIXTURE WATER PROOF
	60*60cm	40 W LED RECESSED IN CEILING
	120cm	2X36W SURFACE FL. LIGHT W.P
	180cm	DECORATIVE POWER LED WALL MOUNTED LIGHTING FIXTURE
	CEILING	EMERGENCY KIT, FOR ANY OF THE LIGHTING FIXTURES, FACTORY ASSEMBLED.
₩	220cm	WALL MOUNTED POINT/FIXTURE - BED ROOMS
	STAIRS	WALL MOUNTED RECESSED POINT/FIXTURE (W.P.)
EXIT	CEILING	SELF-CONTAINED, RECESSED CEILING MOUNTED DOUBLE SIDED EXIT SIGN FOR MAINTAINED EMERGENCY LIGHTING
•	FLOOR	RECESSED ARCHITECTURAL LED FLOODLIGHT
K	FLOOR	GARDEN SPOT LED,24W MINIMUM FIXTURE, IP65
9	160cm	WALL MOUNTED ARCHITECTURAL LED FLOODLIGHT(NARROW BEAM)
<u> </u>	160cm	WALL MOUNTED ARCHITECTURAL LED FLOODLIGHT(WIDE BEAM)
0	CEILING	EMERGENCY LIGHTING LED
		LIGHTING SWITCHES
. L	SINGLE PO	LE ONE GANG SWITCH
ľ	SINGLE PO	LE ONE GANG SWITCH W.P.
ξ .	SINGLE PO	LE TWO GANG SWITCH
.	SINGLE PO	LE TWO GANG SWITCH W.P.
. . . .	SINGLE PO	LE THREE GANG SWITCH
	SINGLE PO	LE THREE GANG SWITCH W.P.
6	SINGLE PO	LE FOUR GANG SWITCH
<u> </u>	TWO WAY S	WITCH
74	INTERMEDIA	TE SWITCH
⊚	PUSH BUTT	ON
	UP-DOWN	SWITCH FOR SHUTTERS
[SINGLE PO	LE SWITCH WITH INDICATION LAMP / W.P.
.	 	DLE SWITCH WITH INDICATION LAMP / W.P.
₩	EXTRACT F	AN
, 	<u></u>	POWER SOCKETS
 \$\dar{\bar{\pi}}	16A 3 F	PIN SOCKET OUTLET 16A 5 PIN SOCKET OUTLET(Industrial 3-phase)
+	16A 3 F	IN SOCKET OUTLET W.P.
#	16A 3 F	PIN TWIN SOCKET OUTLET
	16A 3 F	PIN TWIN SOCKET OUTLET W.P.
	16A 3 F	'IN SOCKET OUTLET FIXED ON CEILING

SYMBOL	DESCRIPTION	
4	16a 3 PIN A/C SOCKET	_
•	10 W SPEAKER	
	ELECTRICAL DISTRIBUTION BOARDS	
	DISTRIBUTION BOARD	
	MAIN ELECTRIC BOARD L.V. SIDE	
	THREE PHASE KWHM	
*	4-POLE CHANGE OVER SWITCH MANUAL OR AUTO	
+ +	THREE/SIGLE PHASE FUSE	
77	THREE/SIGLE PHASE EARTH LEACKAGE RELAY	
<i>7.7</i>	THREE/SINGLE PHASE MCCB	
7 7	THREE/SINGLE PHASE MCB	
SR I	STEP RELAY	
P	TIMER	_
<u> </u>	CONTACTOR	
SATEC	GENERAL MULTIMETER	
B_D.M.M.	AMETER/VOLTMETR	_
<u> </u>	TRANSFORMER	_
	INDICATOR LAMPS WITH PUSH BUTTON	_
		_
	GENERATOR	_
C.B	CHECK BOX	_
©	80*80CM ELECTRICAL MANHOLE	_
(1)	60*60CM TELEPHONE MANHOLE	_
	40*40cm EARTHING PITØ19mm,1.5m CU ROD	_
	L.V. SOCKETS	_
	OUTDOOR CAMERA	_
#\$	DATA SOCKET OUTLET	
<u>~</u>	T.V. SOCKET OUTLET	_
_	INTERCOME SYSTEM	_
	OUTDOOR UNIT	_
	INDOOR UNIT	_
	Safety SYSTEM	_
S ,	PHOTO SMOKE SENSOR/ DITTO BUT WITH INDICATION LAMP ABOVE FALSE CEILING	Έ
(H)	HEAT DETECTOR	_
<u> </u>	GAS DETECTOR	_
	MANUAL CALL POINT/BREAK GLASS	_
3	INTERNAL SIREN	_
当	EXTERNAL SIREN WITH FALSHER	_
I·I		_

	LIST OF DRAWINGS
E00	LEGEND & LIST OF DRAWINGS
E01	LIGHTING SYSTEM GROUND FLOOR
E02	POWER SYSTEM GROUND FLOOR
E03	AIR CONDITION SYSTEM GROUND FLOOR
E04	SOUND SYSTEM PLAN GROUND FLOOR
E05	ELECTRICAL BOARD
E06	
E07	
E08	
E09	
E10	
E11	
E12	
E13	
E14	
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E17	
E 18	
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E 23	
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GENERAL NOTES.

- ALL DISTRIBUTION BOARDS SHALL BE INSTALLED WITH TOP END AT 180cm FROM FFL UNLESS OTHERWISE
 INDICATED.
- ALL LIGHTING SWITCHES SHALL BE INSTALLED AT 135cm FROM FFL. AND TO BE MOUNTED INSIDE THE ROOMS ON THE SIDE OF THE DOOR HANDLE WITHIN 15cm FROM DOOR FRAME UNLESS OTHERWISE INDICATED.
- 3. POWER & LOW VOLTAGE OUTLETS SHALL BE INSTALLED AT 60cm FROM FFL. UNLESS OTHERWISE INDICATED.
- ALL WATER PROOF POWER OUTLETS SHALL BE INSTALLED AT 130cm FROM FFL. UNLESS OTHERWISE INDICATED.
- KWHM PANEL LOCATION COULD COULD BE CHANGED ACCORDING TO LOCAL ELECTRICITY COMPANY REGULATIONS
- 6. CABLING ROUTING IS INDICATIVE ONLY.

RECOMMENDED CONDUITS COLORS PER EACH SYSTEM

INLO	RECOMMENDED CONDOTTS COLORS FER EACH STSTEM		
REF.	SYSTEM	COLOR	
1	PUBLIC ADDRESS, CCTV AND BURGLAR ALARM	WHITE	
2	POWER, AC AND BMS SYSTEMS	GREEN	
3	LIGHTING AND KNX SYSTEMS	BLUE	
4	DATA, TELEPHONE AND ACCESS CONTROL	YELLOW	
5	UPS SYSTEM	BROWN	
6	Safety SYSTEM	RED	

- * OTHERS TO BE COORDINATED WITH THE ENGINEER
- * CONDUITS SHOULD BE PLIABLE SMOOTH FLAME RETARDANT ACCORDING TO ELECTRICAL SPECS.

es:

Legend:

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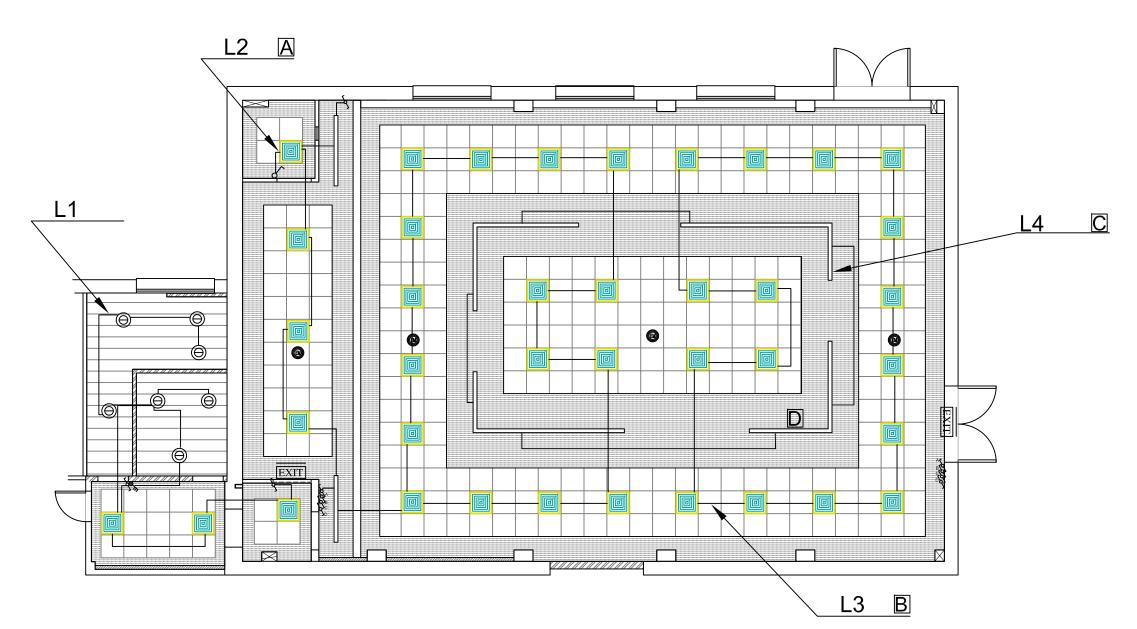
DESIGN DRAWINGS

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DESIGN AND SUPERVISION CONSULTANCY FOR REHABILITATION WORKS AT AL-BEIRUNI SECONDARY BOYS SCHOOL IN AL-RAM

Drawing Title
PROPOSED GROUND FLOOR
ELECTRICAL LEGEND

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Prepared by	V.DAOUD	1:100
		@ A3
		Sheet No.
Date	APR,2025	E-00



Note: The lighting circuits will be connected to the existing distribution board (DB) on the SAME floor. There are existing 10A circuit breakers, and the contractor is responsible for connecting the lines accordingly.

Note:Emergency light will connected to the nearest lighting circuit

Note:The contractor shall fix the Up/Down wall light Which is fixed at the wood decor at the same existing lighting linya and point TYPE D

Legend:

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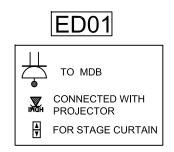



DESIGN DRAWINGS

DESIGN AND SUPERVISION CONSULTANCY FOR REHABILITATION WORKS AT AL-BEIRUNI SECONDARY BOYS SCHOOL IN AL-RAM

Drawing Title PROPOSED GROUND FLOOR

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Prepared by	V.DAOOD	1:100	
		@ A3	
		Sheet No.	
Date	APR,2025	E-01	



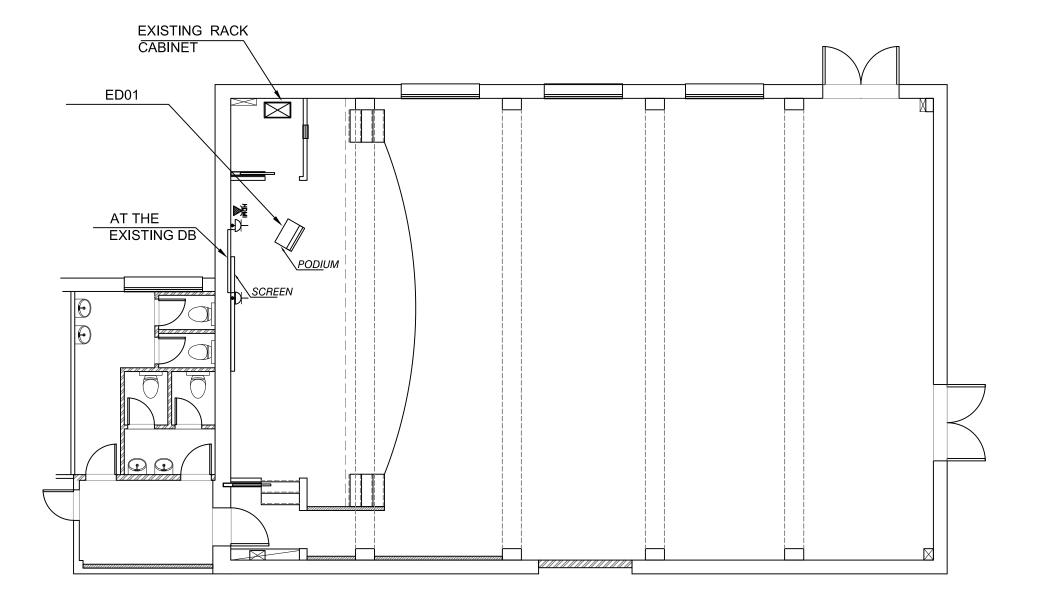

Note: The contractor must inspect, maintain, and test all existing power sockets. each socket should be labeled to indicate its corresponding sub-board on the existing panel.

Legend:

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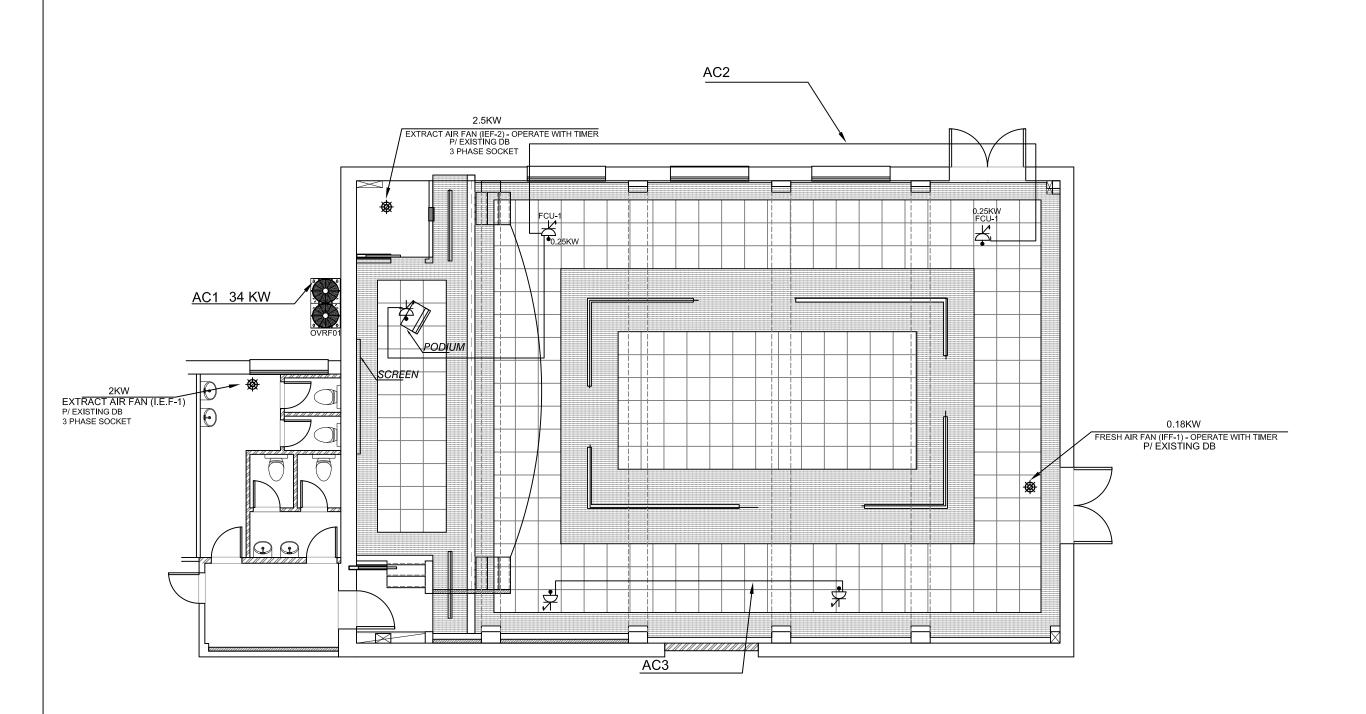


DESIGN DRAWINGS

DESIGN AND SUPERVISION CONSULTANCY FOR REHABILITATION WORKS AT AL-BEIRUNI SECONDARY BOYS SCHOOL IN AL-RAM

Drawing Tide
PROPOSED GROUND FLOOR PLAN
POWER SYSTEM
| Scale

Sheet No.	Prepared by	V.DAOUD	1:100 @ A3	
Date		APR.2025	Sheet No.	l



Note: The contractor must inspect, maintain, and test all existing power sockets. each socket should be labeled to indicate its corresponding sub-board on the existing panel.

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REV.	DATE	DESCRIPTION
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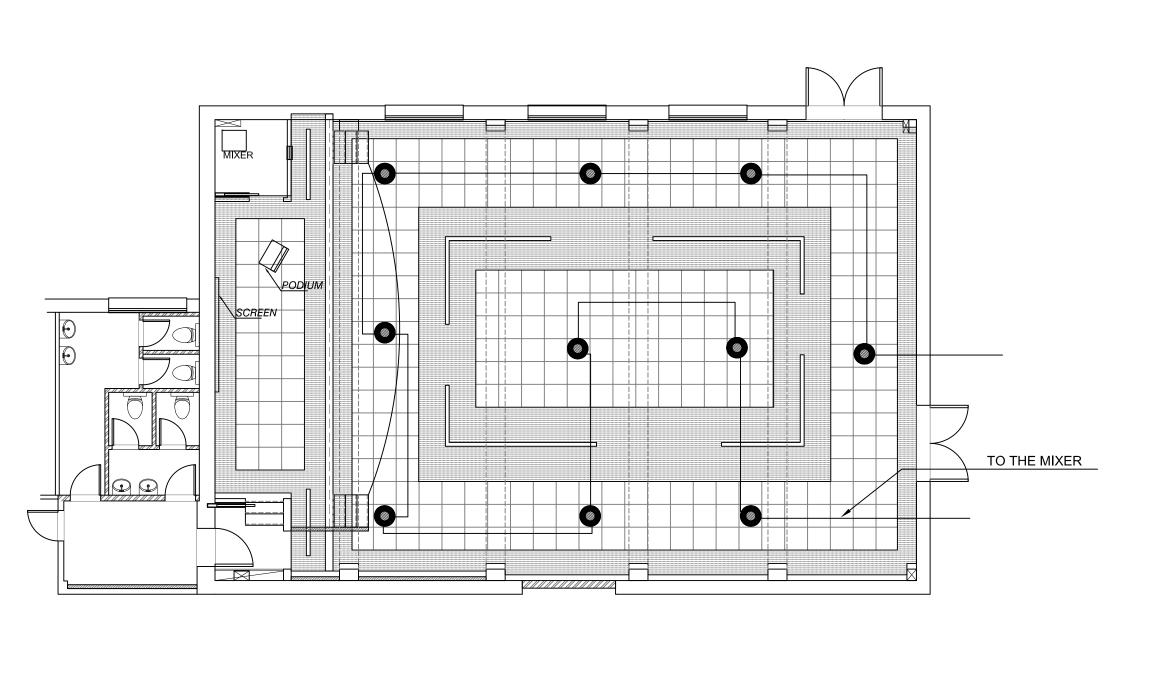


DESIGN DRAWINGS

DESIGN AND SUPERVISION
CONSULTANCY FOR
REHABILITATION WORKS AT
AL-BEIRUNI SECONDARY BOYS
SCHOOL IN AL-RAM

Drawing Title
PROPOSED GROUND FLOOR PLAN
AIR CONDITION SYSTEM

Prepared by V.DAOUD Date APR,2025	V.DAOUD	Scale 1:100 @ A3
		Sheet No.
Date	APR,2025	E-03



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Legend:

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DESIGN DRAWINGS


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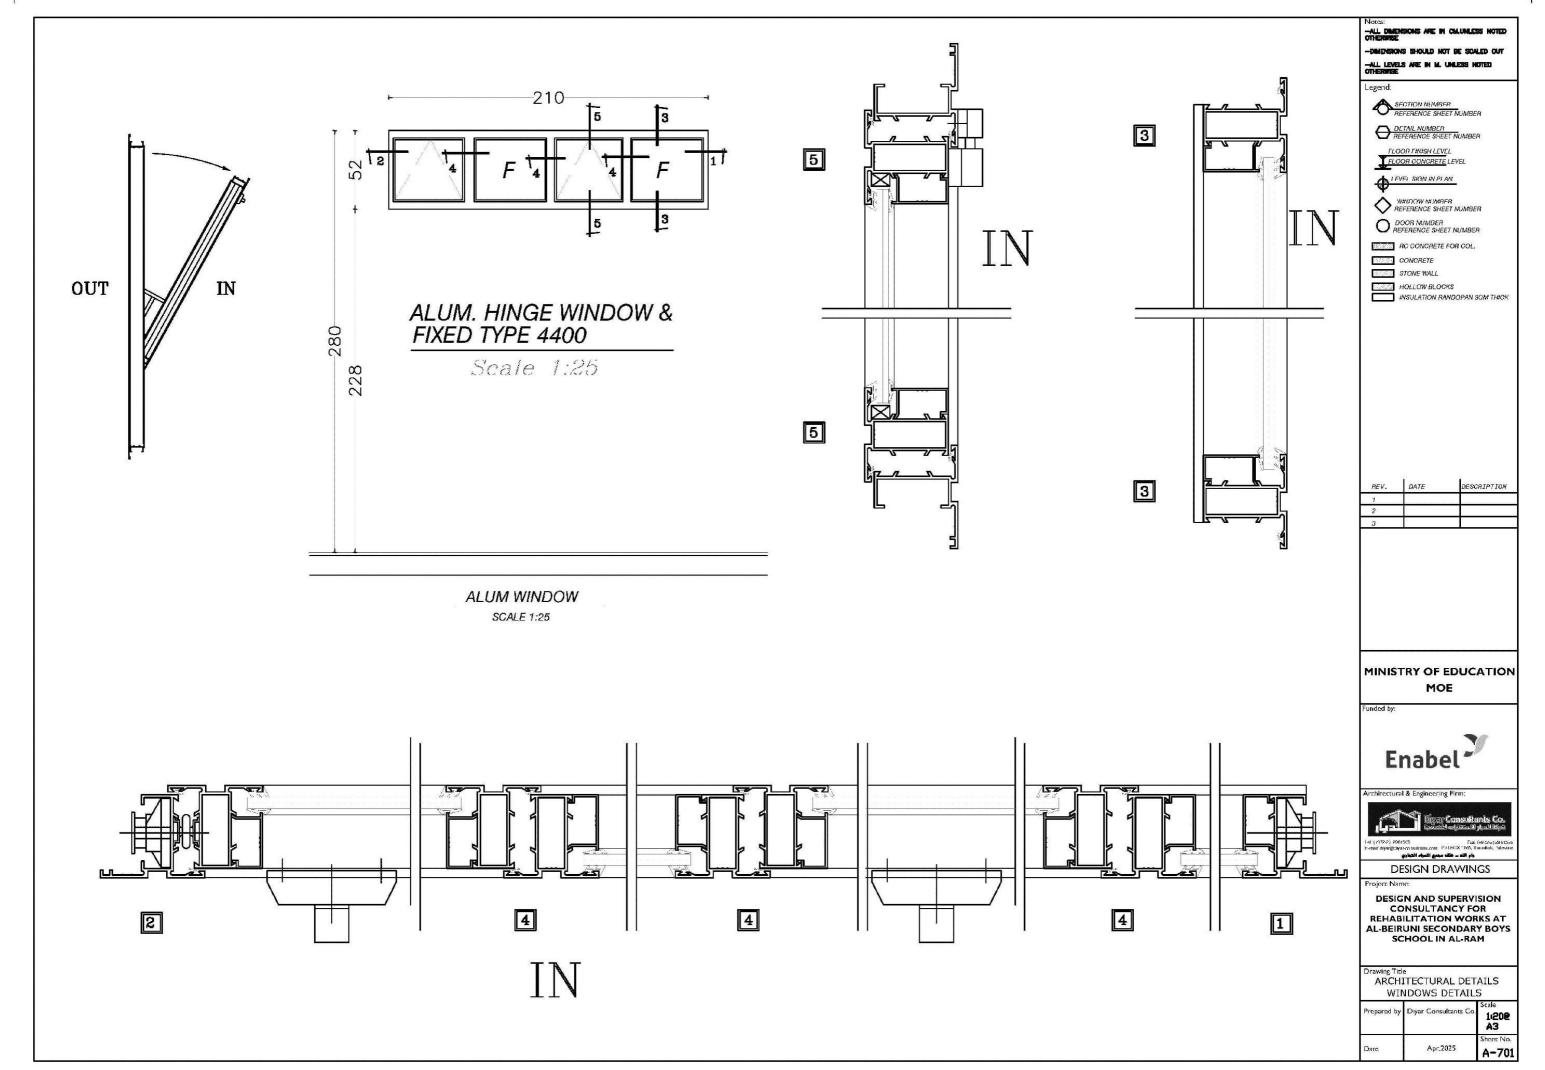
DESIGN AND SUPERVISION
CONSULTANCY FOR
REHABILITATION WORKS AT
AL-BEIRUNI SECONDARY BOYS
SCHOOL IN AL-RAM

Drawing Title
PROPOSED GROUND FLOOR PLAN
SOUND SYSTEM
Prepared by V.DAOUD
Scale

APR,2025

E-04



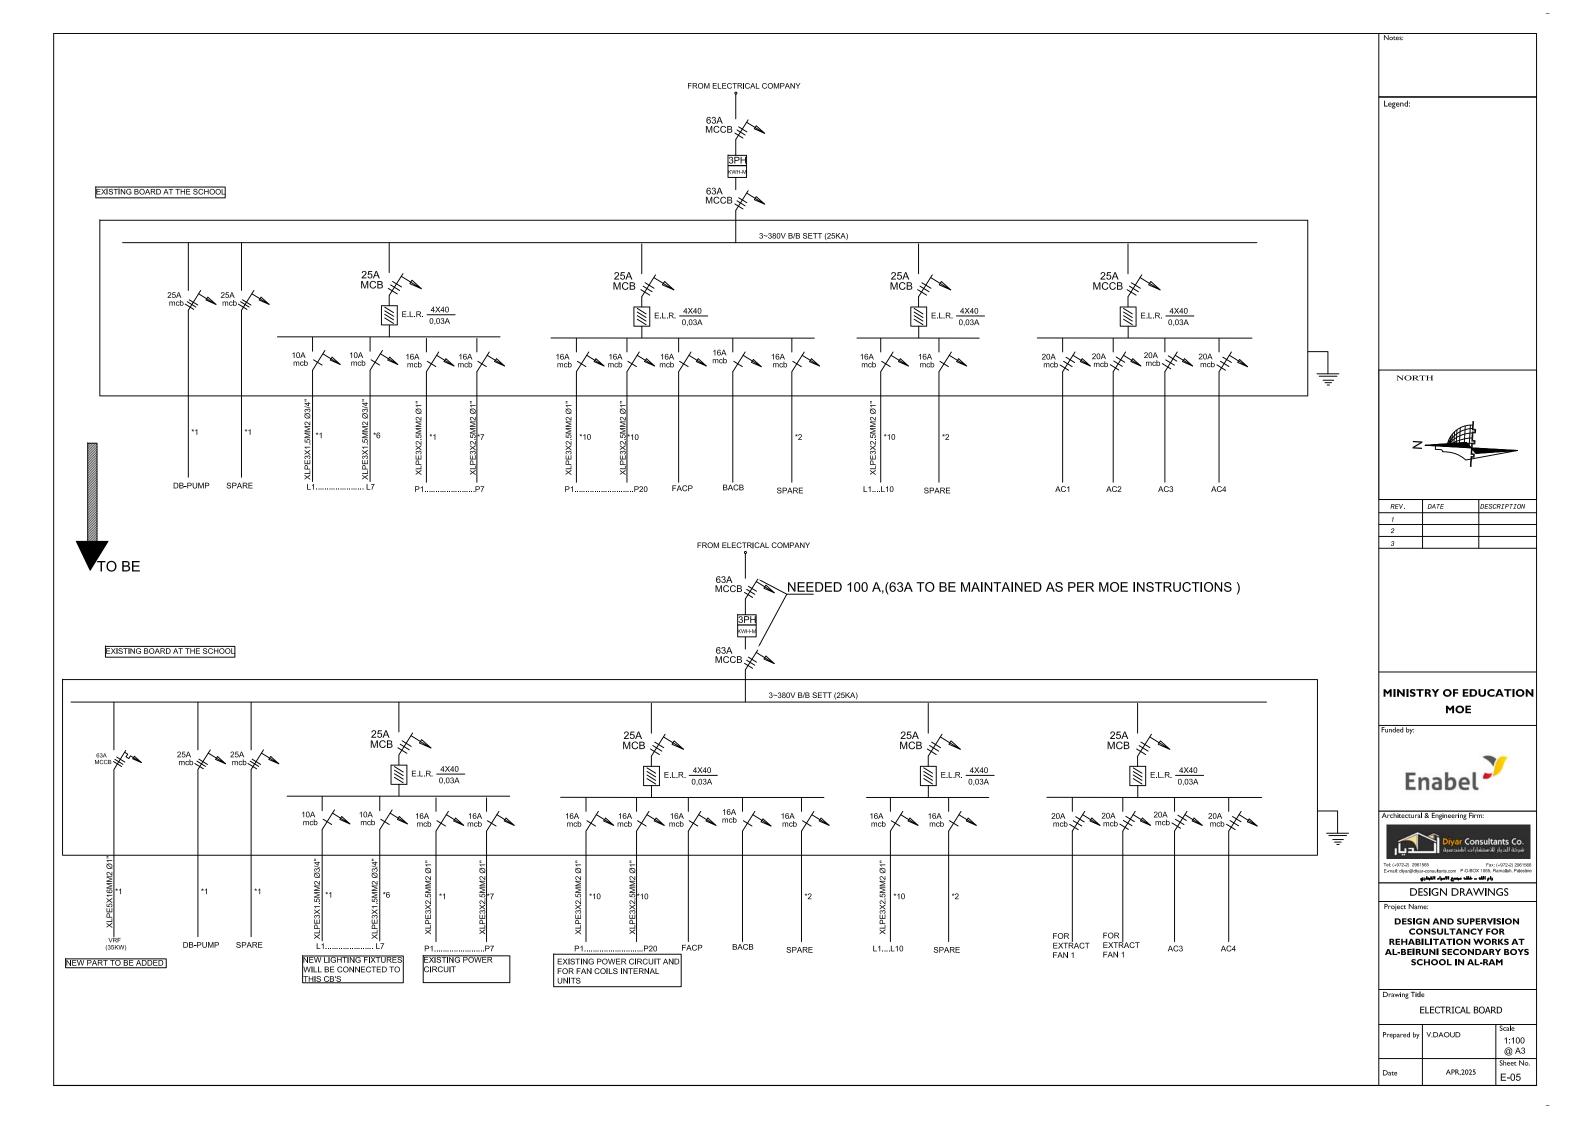


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MINISTRY OF EDUCATION	
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Architectural & Engineering Firm:



رام الله ــ خلف مهمج الأسراء الكيناري **DESIGN DRAWINGS**

DESIGN AND SUPERVISION CONSULTANCY FOR REHABILITATION WORKS AT **AL-BEIRUNI SECONDARY BOYS** SCHOOL IN AL-RAM

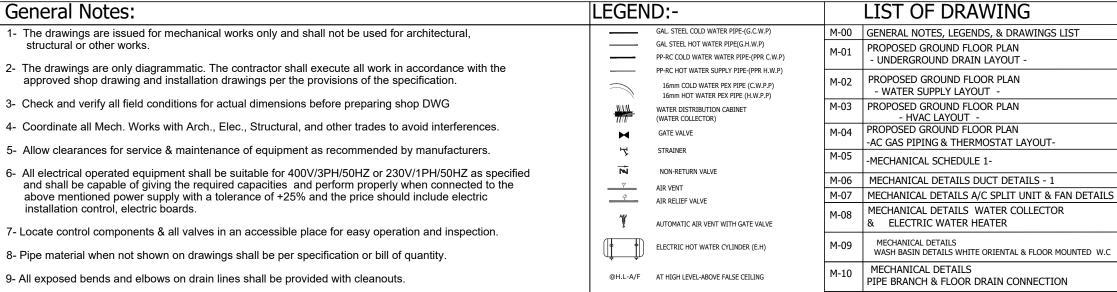
GENERAL NOTES, LEGENDS, & DRAWINGS LIST

Prepared by	Diyar Consultants Co.	Scale 1:100
Date	Feb,2025	Sheet No. M00



-ALL DIMENSIONS ARE IN CM.UNLESS NOTED OTHERWISE -DIMENSIONS SHOULD NOT BE SCALED OUT -ALL LEVELS ARE IN M. UNLESS NOTED OTHERWISE

Legend:

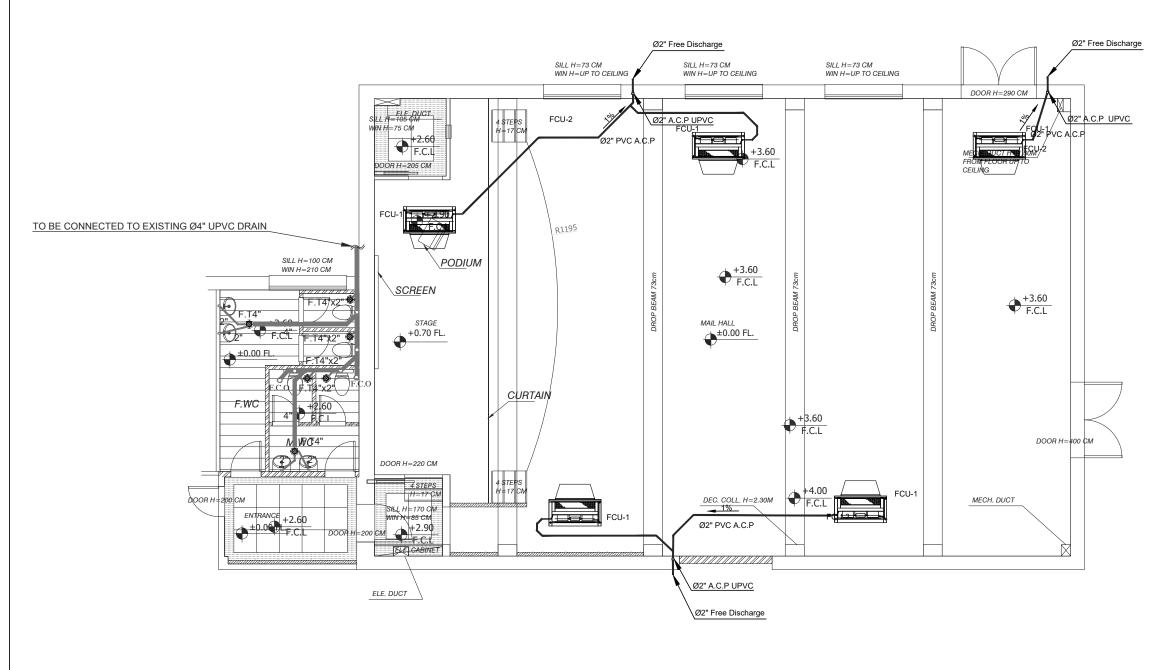

NOTES:

NOTES 1: FOR VRF & AC SYSTEM CONDENSATE PIPE: ALL PIPES ARE Ø2" UPVC AC CONDENSATE PIPE (PN 10) AT HIGH LEVEL-ABOVE FALSE CEILING WITH SLOPE 1% FREE DISCHARGE OUT SIDE

NORTH

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Architectural & Engineering Firm:





DESIGN DRAWINGS

DESIGN AND SUPERVISION CONSULTANCY FOR REHABILITATION WORKS AT **AL-BEIRUNI SECONDARY BOYS** SCHOOL IN AL-RAM

Drawing Title
PROPOSED GROUND FLOOR PLAN - UNDERGROUND DRAIN LAYOUT -1:100 Feb,2025

M01

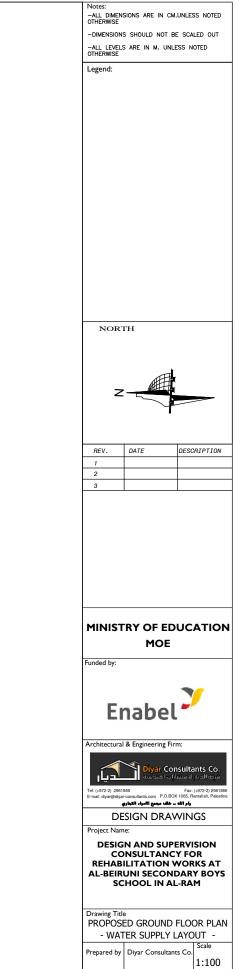

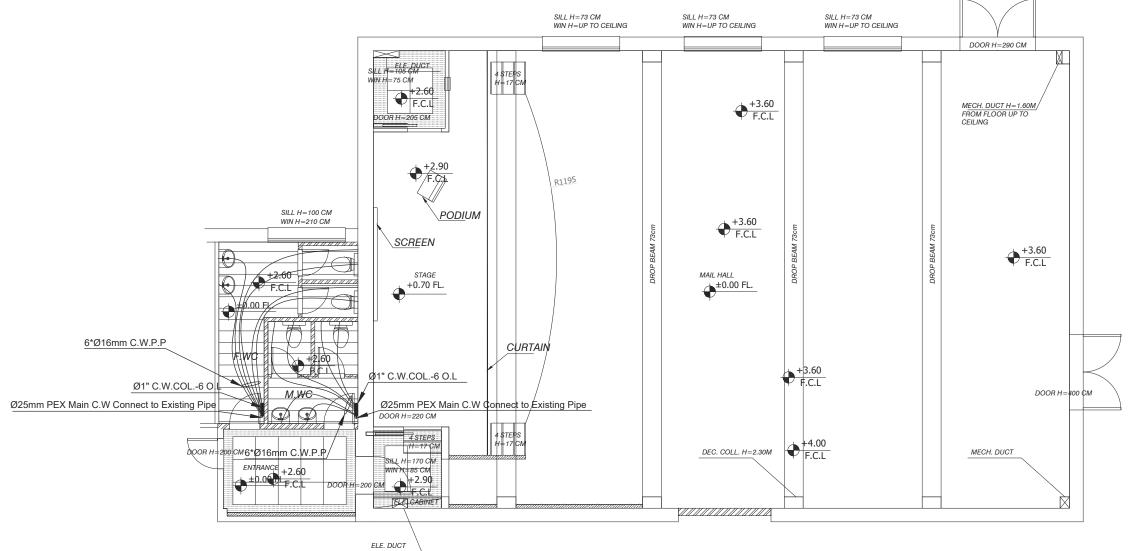


Prepared by Diyar Consultants Co.


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1:100


Date Feb.2025 Sheet No.
M02

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Feb,2025 M04

-ALL DIMENSIONS ARE IN CM.UNLESS NOTED OTHERWISE -DIMENSIONS SHOULD NOT BE SCALED OUT -ALL LEVELS ARE IN M. UNLESS NOTED OTHERWISE

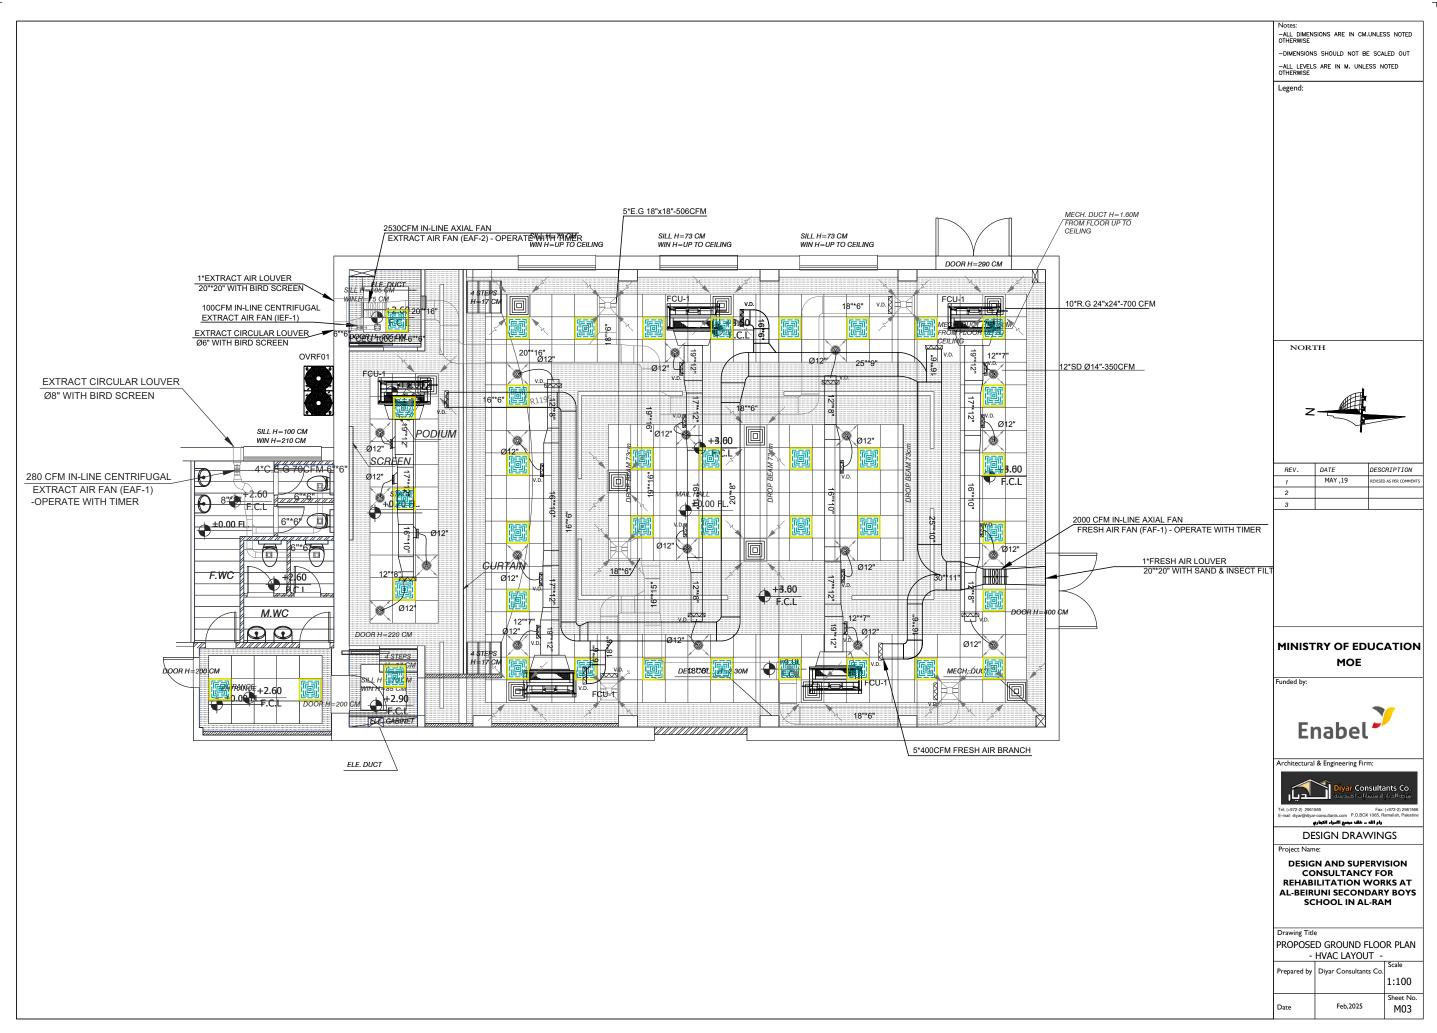Legend:

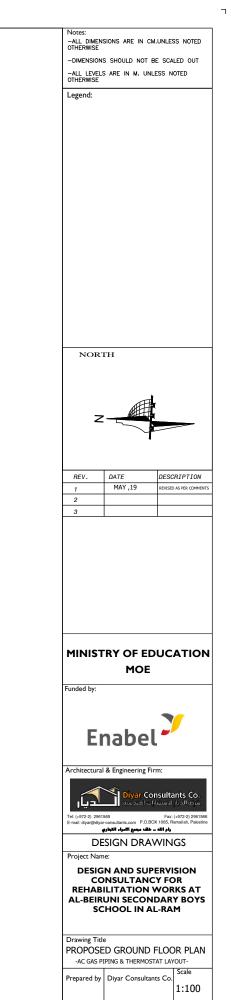				SPLIT	UNIT / FAN COI	L VRF INDOOR	UNITS SC	HEDULE							
					GF	ROUND FLOOR									
	INDOOR UNIT	TOTAL COOLING	TOTAL COOLING	HEATING AIR FLOW				ELECTRIC DATA		ENTERING	S AIR TEMP.	LEAVING	AIR TEMP.	QUANTITY	
NO.	TYPE	LOAD (KW)	LOAD (Ton)	(KW)	(CFM) PRESSURE (PA)	POWER (W)	VOLTS (V)	Ø	HZ	DB C°	WB C°	DB C°	WB C°	Q0/	
FCU-1	CONCEALED CEILING MOUNTED PLENUM, DUCTED	13.0	3.71	11	1400	150	485	220	1	50	25.8	16.5	12.5	11.5	5
ALL INDOOR	UNITS SHOULD	BE SELECTED	AT NOMINAL S	PEED											
	R & OUTDOOR U				IN COC	DLING: INDOOR	TEMPERA	ATURE 23°	°C & OU	TDOOR	TEMPERA	ATURE 35	5°C & HUI	MIDITY RA	TIO 50%
(SELECTION)) ACCORDING T AS BE		CONDITIONS		IN HEA	ATING: INDOOR	TEMPERA	ATURE 22	2°C & OL	ITDOOR	TEMPER	ATURE 0	°C & HUN	MIDITY RA	TIO 85%

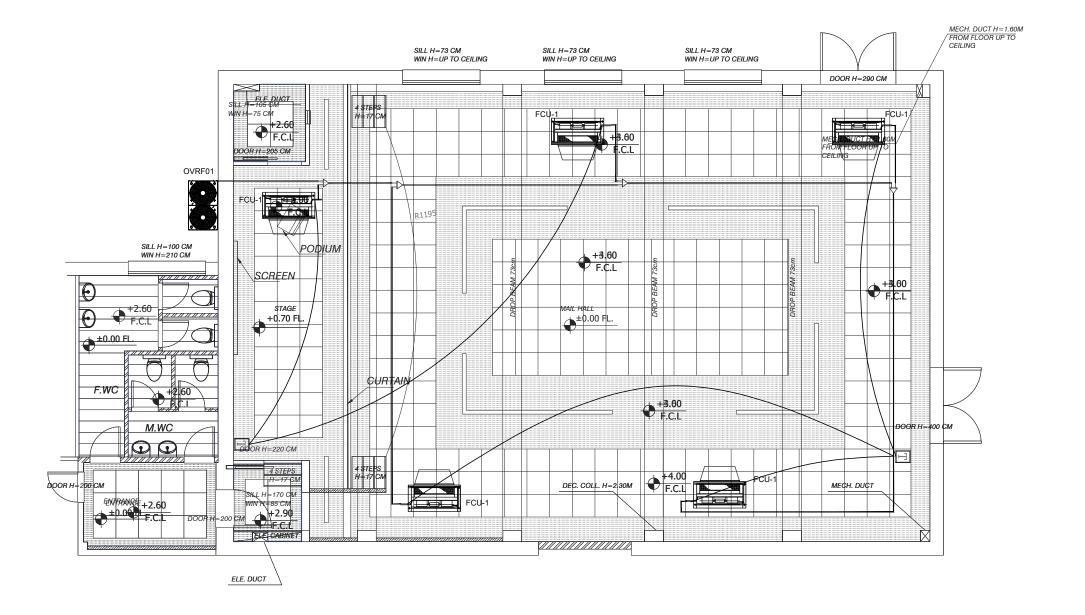HEAT PUMP VRF OUTDOOR UNIT SCHEDULE						
NAME	QTY	COOLING LOAD (Kw)	HEATING LOAD (Kw)	ESTIMATED INPUT POWER (kW)	Elec. Details V/Hz/Ph	SERVED AREA
OVRF01	1	66.0	58.0	35	400/50/3	GROUND FLOOR STAGE AREA

				FANS S	SCHEDULE	- IN-LINE 7	ГҮРЕ				
FAN DESIGN	SERVED AREA	SYSTEM	AIR FLOW (CFM)	ESTM. EXT. TOTAL SP (INCH OF	MOTOR DATA				ТҮРЕ	QUANTITY	
				CFM) (MATER)		POWER (KW)	VOLTS (V)	Ø	HZ		
EAF-1	TOILETS	DIRTY EXTRACT	280	0.40	2400	0.18	230	1	50	IN-LINE AXIAL FAN IN PLASTIC & OPERATE BY TIMER	1
EAF-2	MAIN HALL STAGE	EXTRACT	2530	0.80	1500	2.50	380-415	3	50	IN-LINE AXIAL FAN IN METAL & OPERATE BY TIMER	1
FAF-1	MAIN HALL STAGE	FRESH AIR	2000	0.80	2400	2.00	380-415	3	50	IN-LINE CENTRIFUGAL FAN IN METAL OPERATE BY TIMER	1

NORTH



REV.	DATE	DESCRIPTION			
1	MAY ,19	REVISED AS PER COMMENTS			
2					
3					

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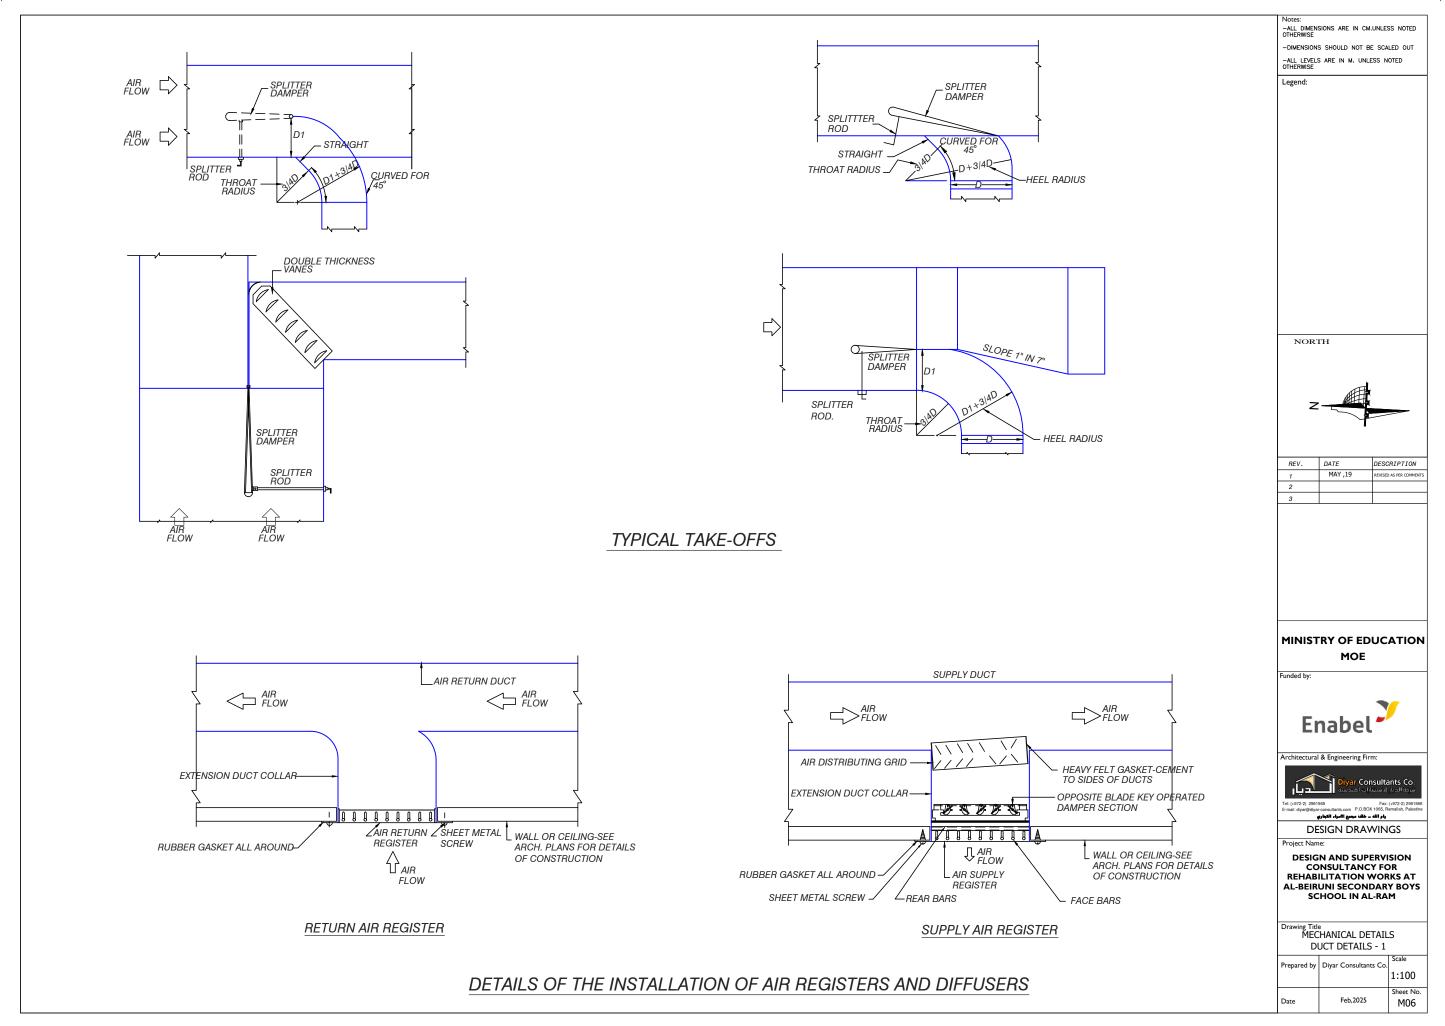
DESIGN DRAWINGS

DESIGN AND SUPERVISION
CONSULTANCY FOR
REHABILITATION WORKS AT
AL-BEIRUNI SECONDARY BOYS
SCHOOL IN AL-RAM


Drawing Title

-MECHANICAL SCHEDULE 1-

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Date	Feb,2025	Sheet No. M05



-ALL DIMENSIONS ARE IN CM.UNLESS NOTED OTHERWISE

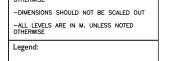

NORTH

-MOTORISED AUTOMATIC DAMPER NORMALLY CLOSED

PROTECTION LOUVER

ALUMINUM FRAME



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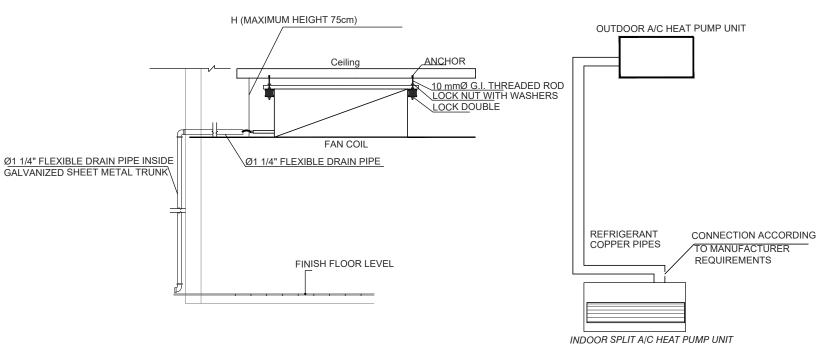
رام الله ــ خلف ميميع الأسراء الكيماري

DESIGN DRAWINGS

DESIGN AND SUPERVISION CONSULTANCY FOR REHABILITATION WORKS AT AL-BEIRUNI SECONDARY BOYS SCHOOL IN AL-RAM

Drawing Title
MECHANICAL DETAILS A/C SPLIT UNIT & FAN DETAILS

1:100 Feb,2025 M07



A/C DRAINAGE LAYOUT DETAIL

WATER TIGHT AUTOMATIC DAMP

SECURE DAMPER TO BLOCKING

FLOW


ORIFICE RING

BUILDING WALL

DETAILS OF THE INSTALLATION

OF EXTRACT FAN

A/C SPLIT HEAT PUMP INVERTER UNIT DIAGRAM

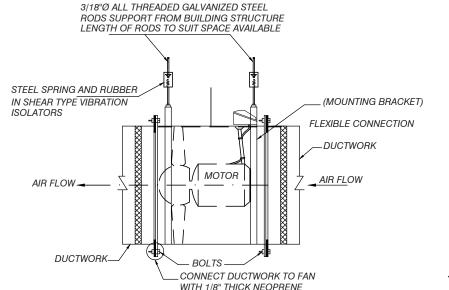

WITH 1/8" THICK NEOPRENE GASKET

GASKET WITH 3mm (1/8") THICK NEOPRENE CENTRIFUGAL FAN DETAIL CONNECT DUCTWORK TO FAN 13mm THICK 15X15cm STEEL PLATE -EXHAUST AIR FAN ROD SUPPORT EXPANSION BOLT-16mm. ALL THREAD ROD SUPPLY DUCT lack MOUNTING BRACKET LFLEXIBLE CONNECTION EXHAUST AIR GRILL

AIR LOUVER ALUMINUM INSECTS SCREEN(BIRD SCREEN) EXHAUST AIR DUCT CONNECTION BY RECTANGULAR AND/OR CIRCULAR DUCT TO CONNECTIONS BETWEEN AIR LOUVER AND EXHAUST FAN BY BY SPECIAL FITTINGS CONNECTION

STAIR CASE SIDE

ACTUATOR -

TYPICAL PROPELLER FAN DETAIL

-SUPPORT ROD FROM BUILDING STRUCTURE

STEEL SPRING AND RUBBER IN SHEAR TYPE

VIRBRATION ISOLATORS

IN-LINE EXHAUST AIR FAN WITH DUCTET CONNECTION

& TYPICAL FOR INLINE FRESH AIR FAN

MOTOR

PROVIDE ELECRICAL CONNECTION WITH FLEXIBLE METAL

CONDUIT

CASING IN WALL


COLD WATER SUPPLY
HOT WATER SUPPLY
FROM WATER HEATING SYSTEM

COUPLING
STOP VALVE

BALL VALVE

F.F.L

TYPICAL WATER CABINET
HOT & COLD WATER COLLECTORS
AND METAL CABINET DOOR WITH DOUBLE DOORS

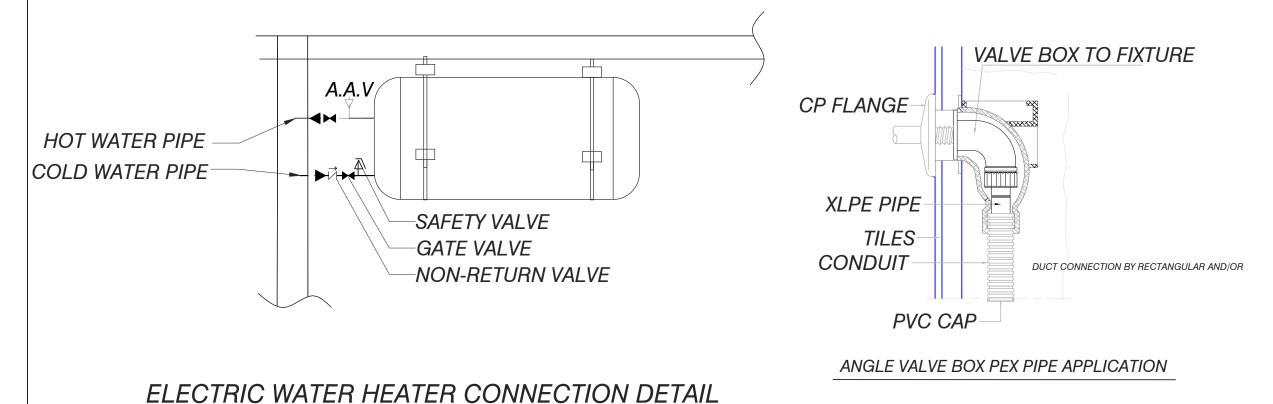

Notes:

-ALL DIMENSIONS ARE IN CM.UNLESS NO OTHERWISE

-DIMENSIONS SHOULD NOT BE SCALED O -ALL LEVELS ARE IN M. UNLESS NOTED OTHERWISE

Legen

NORTH



REV.	DATE	DESCRIPTION
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2		

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DESIGN DRAWINGS

roject Name:

DESIGN AND SUPERVISION CONSULTANCY FOR REHABILITATION WORKS AT AL-BEIRUNI SECONDARY BOYS SCHOOL IN AL-RAM

Drawing Little
MECHANICAL DETAILS
WATER COLLECTOR
& ELECTRIC WATER HEATE

Prepared by Diyar Consultants Co. 1:100

Date Feb,2025 Scale 1:100

M08

-ALL DIMENSIONS ARE IN CM.UNLESS NOTED OTHERWISE -DIMENSIONS SHOULD NOT BE SCALED OUT -ALL LEVELS ARE IN M. UNLESS NOTED OTHERWISE Legend: Mirror 40x60cm with white Aluminum Frame 85cm 85cm NORTH 1/2 ANGEL W.VALVE 1/2 ANGEL W.VALVE (45-50) CM (50-55) CM 2" P.V.C PIPE DESCRIPTION
REVISED AS PER COMMENT. REV. DATE C. & H. W.P 16mm MINISTRY OF EDUCATION MOE -68.5 -47.6- **Enabel** Architectural & Engineering Firm: 80 \bigcirc P.V.C TRAP 76.2 C.&H. W.P 16mm رام الله ــ خلك ميميع الأسراء الثيماري DESIGN DRAWINGS DESIGN AND SUPERVISION CONSULTANCY FOR REHABILITATION WORKS AT Ø2" DRAIN TO -50-FLOOR DRAIN FLOOR TRAP AL-BEIRUNI SECONDARY BOYS SCHOOL IN AL-RAM $\vdash F.F.L$ C. W.P 16mm Drawing Title

MECHANICAL DETAILS

WASH BASIN DETAILS WHITE ORIENTAL & FLOOR

MOUNTED W.C

| Scale 0 30/5 = 4 4: juyo.pne WASH BASIN WITH MIXER (P) TRAP 1:100 Feb,2025 M09

